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REVISIONS

No.	Date	Details	By

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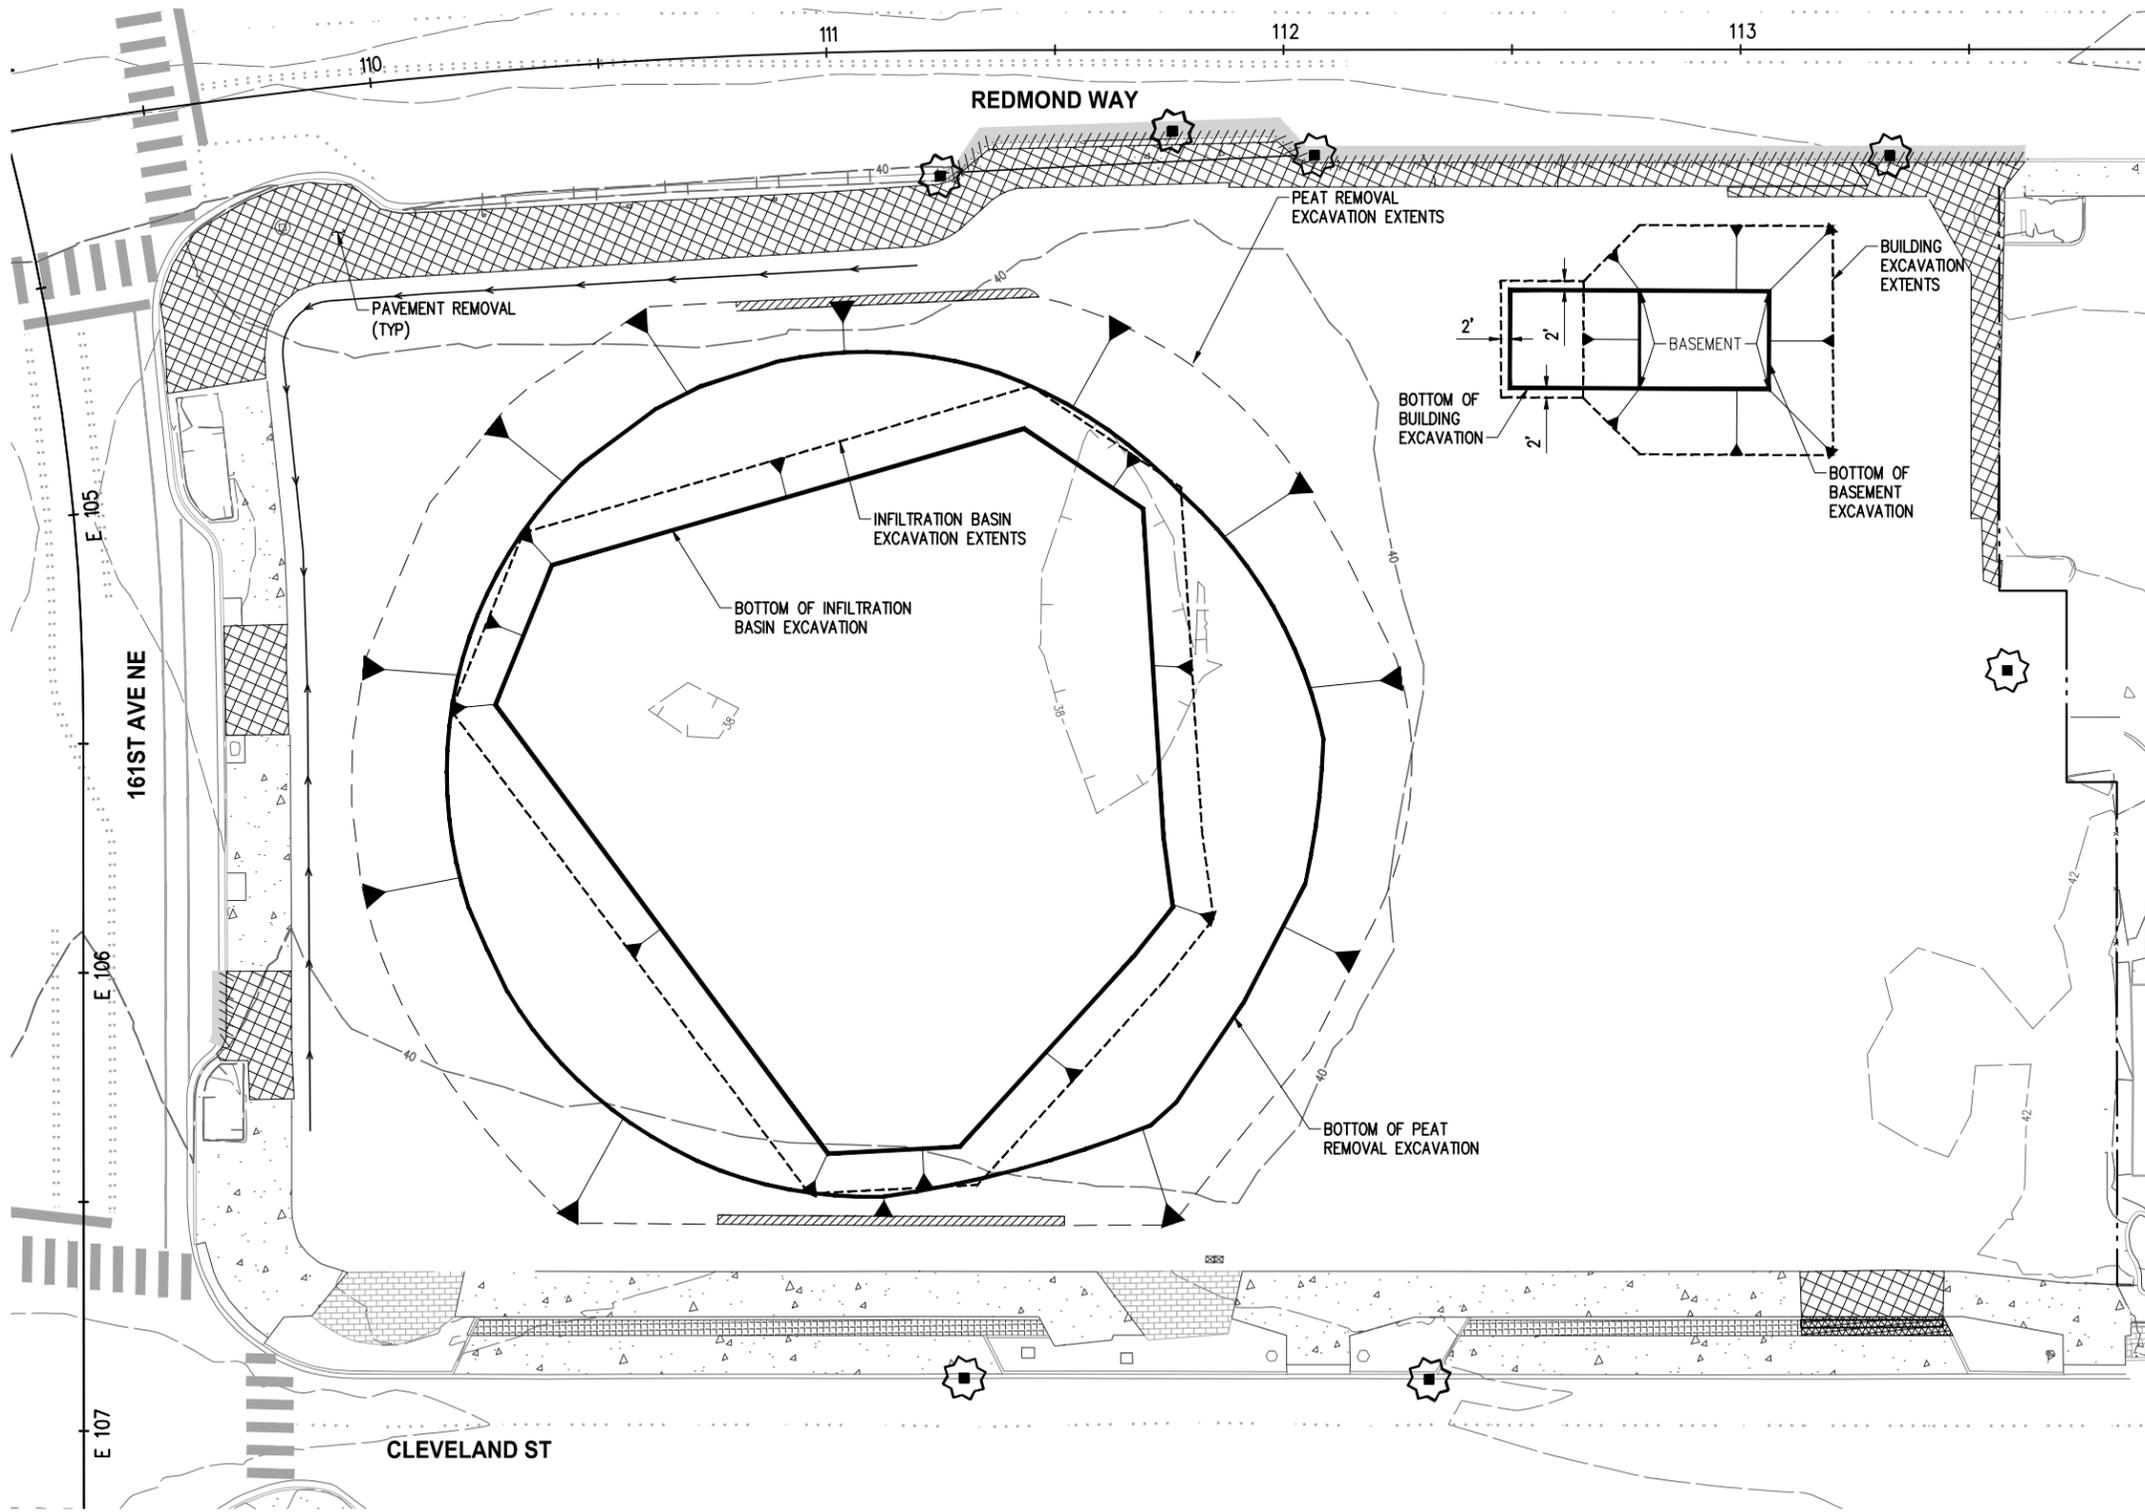
PROJECT  
 Redmond Park

DRAWING TITLE  
**SEPA SITE PLAN**

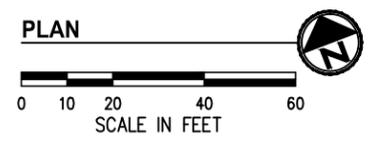
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DATE	PFS PROJECT No.
	15003
SCALE	DRAWING No.
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--- EXISTING MAJOR CONTOUR LINE  
 - - - EXISTING MINOR CONTOUR LINE



- NOTE:**
1. INFILTRATION BASIN EXCAVATION SHALL BE APPROXIMATELY 6' BELOW EXISTING GRADE.
  2. NET ELEVATION CHANGE AT HIGHEST POINT SHALL BE APPROXIMATELY 4' ABOVE EXISTING GRADE.
  3. STRUCTURE EXCAVATION NOT TO EXCEED 10' FOR FINISHED GRADE OF BASEMENT.
  4. SEE PEAT REMOVAL CROSS SECTIONS FOR DEPTH OF EXCAVATION
  5. ALL EXCAVATION SHALL USE 1.5H:1V SIDE SLOPES



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**REVISIONS**

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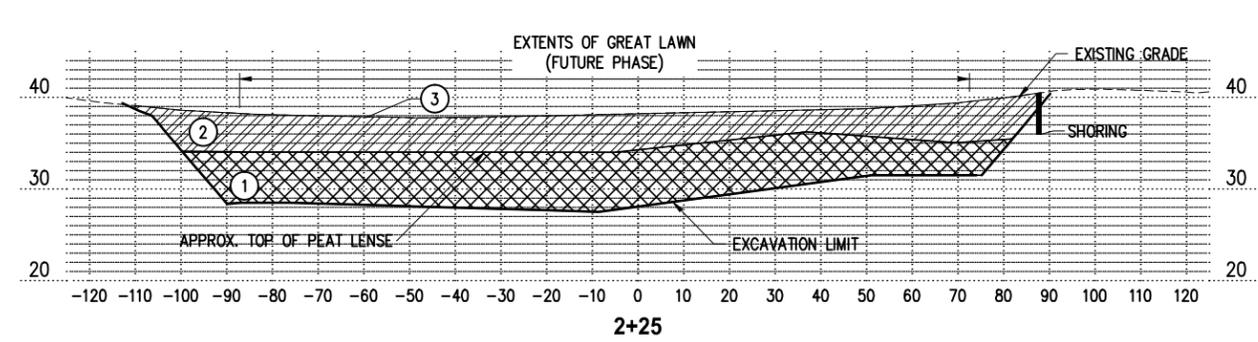
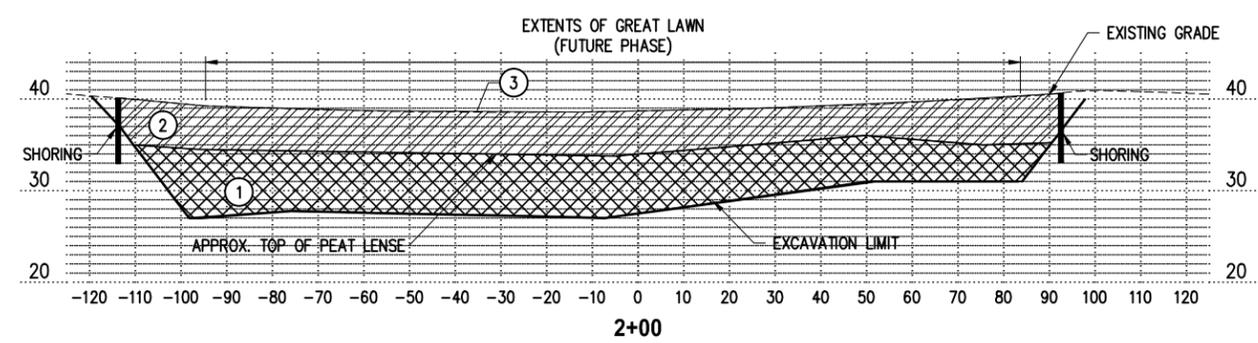
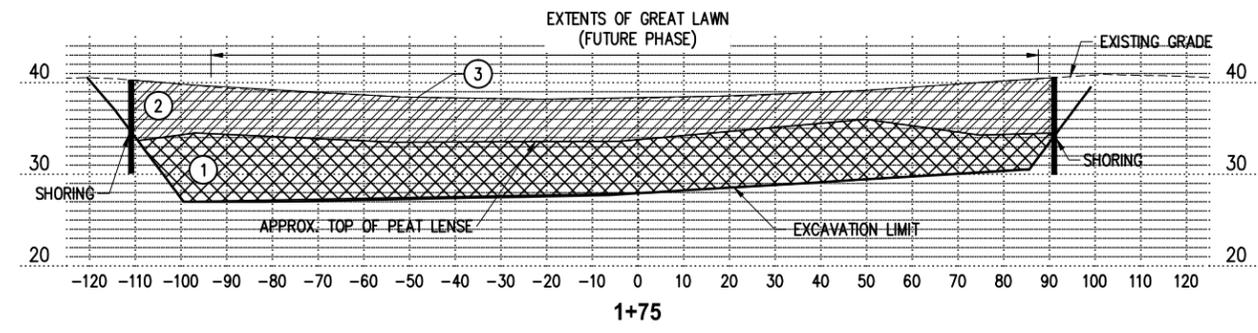
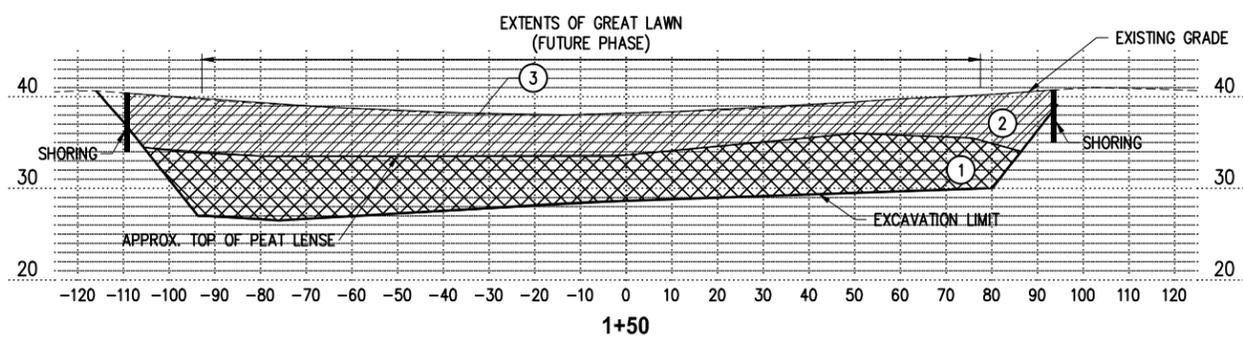
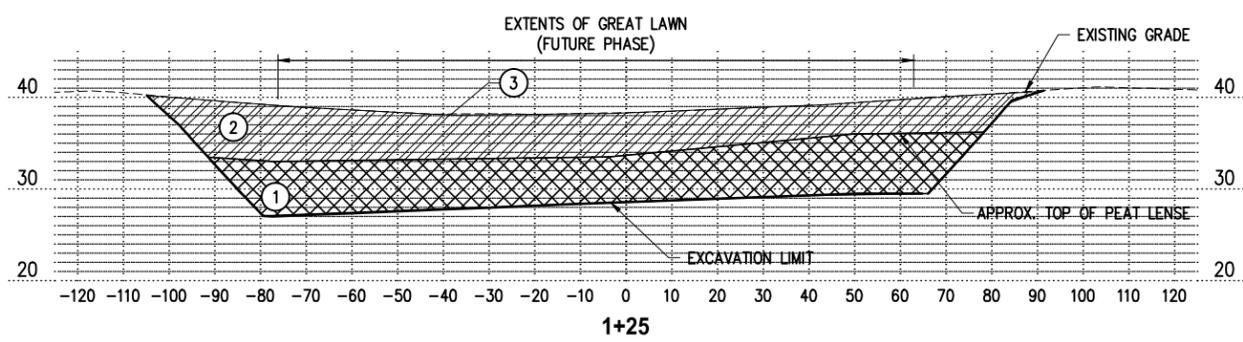
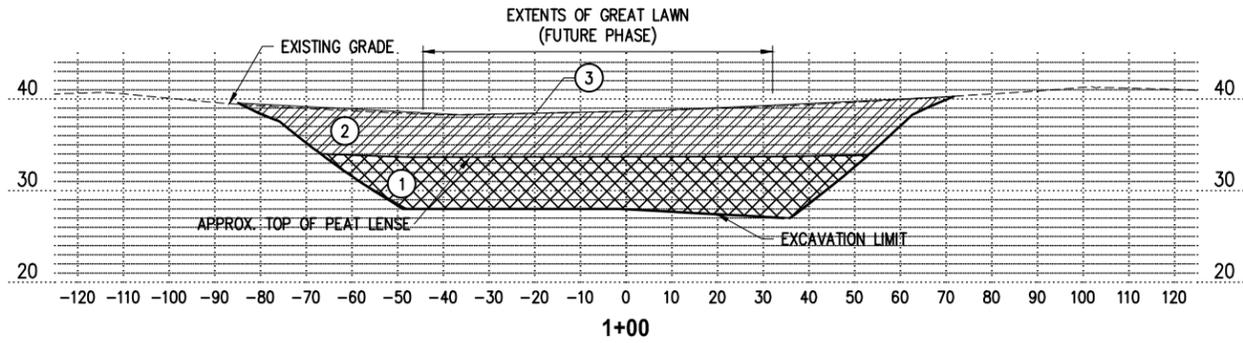
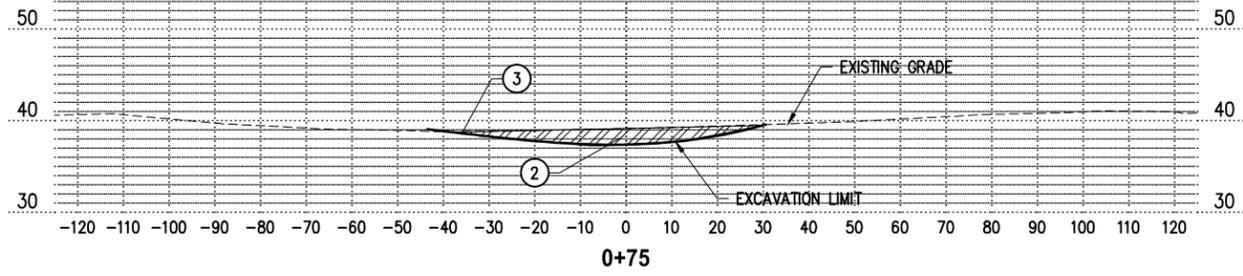
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DRAWING TITLE  
**SEPA SITE PREPARATION PLAN**

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**GENERAL NOTES**

1. FIELD CONDITIONS DETERMINE SAFE SLOPE, OTHERWISE 1.5H:1V
2. RE-USE OF GRANULAR FILL WILL NOT BE ALLOWED.
3. BACKFILL TO APPROXIMATE EXISTING GRADE. ELEV. ±38

**ORDER OF EXCAVATION**

- ① [Cross-hatched pattern] UNSUITABLE FOUNDATION EXCAVATION INCL. HAUL, FOR PEAT ~5,670 CY
- ② [Diagonal hatched pattern] SITE EXCAVATION ~6,300 CY
- ③ [White box] GRAVEL BORROW INCL. HAUL FOR BACKFILL. BACKFILL LIMITS EQUAL TO AREAS ① & ②. ~11,970 CY

**SECTION**  
HOR: 1"=40' VER: 1"=20'



NO.	DATE	BY	CKD.	REVISION

**BID DOCUMENT**

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SECTION: 11 & 12  
TOWNSHIP: T25N  
RANGE: R5E

DESIGNED BY: BMC  
DRAWN BY: BMC  
CHECKED BY: SA  
DATE: 02/2016  
FILE: 15051PR\_XSEC.dwg

**DT PARK PEAT REMOVAL**  
**PEAT REMOVAL CROSS SECTIONS**

15051  
PROJECT NO.

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